

MHCHS AFFORDABLE HOUSING PROJECT - BUILDING 'B'

MEDICINE HAT, ALBERTA



PRIME CONSULTANT / ARCHITECT
FWBA ARCHITECTS

STRUCTURAL CONSULTANT
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LIST OF DRAWINGS

ARCHITECTURAL		STRUCTURAL		MECHANICAL		ELECTRICAL		CIVIL	
SHEET NO.	NAME / TITLE	SHEET NO.	NAME / TITLE	SHEET NO.	NAME / TITLE	SHEET NO.	NAME / TITLE	SHEET NO.	NAME / TITLE
A01-01	COVER PAGE	S000	NOTES	M00-01	MECHANICAL LEGEND	E00-01	ELECTRICAL LEGEND	C1.1	LEGENDS AND ABBREVIATIONS
A02-01	SITE PLAN - OVERALL	S001	STRUCTURAL SCHEDULES	M01-01	MECHANICAL SITE PLAN	E01-01	ELECTRICAL LEGEND	C1.2	EXISTING SITE PLAN
A02-02	SITE PLAN - SOUTH	S100	FOUNDATION PLAN - 3-STORY	M02-01	DWV - LEVEL 1 FLOOR PLAN	E02-01	ELECTRICAL SITE PLAN	C1.3	PROPOSED UNDERGROUND SITE PLAN
A02-04	SITE SURVEY	S101	MAIN FLOOR FRAMING PLAN - 3-STORY	M02-02	DWV - LEVEL 2 FLOOR PLAN	E02-02	POWER AND SYSTEMS - LEVEL 1 FLOOR PLAN	C1.4	PROPOSED SITE GRADING PLAN
A03-01	GENERAL NOTES, SYMBOLS, LEGEND, PROJECT ASSESSMENT & ABBREVIATIONS	S102	2ND FLOOR FRAMING PLAN - 3-STORY	M02-03	DWV - LEVEL 3 FLOOR PLAN	E02-03	POWER AND SYSTEMS - LEVEL 2 FLOOR PLAN	C1.5	STORM WATER MANAGEMENT PLAN
A03-02	CONSTRUCTION ASSEMBLIES	S103	3RD FLOOR FRAMING PLAN - 3-STORY	M03-01	PIPING - LEVEL 1 FLOOR PLAN	E03-01	POWER AND SYSTEMS - LEVEL 3 FLOOR PLAN	C1.6	DETAILS
A03-03	EGRESS & RATINGS PLAN - LEVEL 1	S400	STRUCTURAL DETAILS	M03-02	PIPING - LEVEL 2 FLOOR PLAN	E03-02	LIGHTING - LEVEL 1 FLOOR PLAN		
A03-04	EGRESS & RATINGS PLAN - LEVEL 2	S402	TALL WALL DETAILS	M03-03	PIPING - LEVEL 3 FLOOR PLAN	E03-03	LIGHTING - LEVEL 2 FLOOR PLAN		
A03-05	EGRESS & RATINGS PLAN - LEVEL 3	S403	ELEVATOR SHAFT & TALL WALLS	M04-01	HVAC - LEVEL 1 FLOOR PLAN	E04-01	LIGHTING - LEVEL 3 FLOOR PLAN		
A04-01	FLOOR PLAN - LEVEL 1	S500	SITE DETAILS	M04-02	HVAC - LEVEL 2 FLOOR PLAN	E04-02	FIRE ALARM - LEVEL 1 FLOOR PLAN		
A04-02	FLOOR PLAN - LEVEL 2			M04-03	HVAC - LEVEL 3 FLOOR PLAN	E04-03	FIRE ALARM - LEVEL 2 FLOOR PLAN		
A04-03	FLOOR PLAN - LEVEL 3			M05-01	MECHANICAL ROOM	E04-04	FIRE ALARM - LEVEL 3 FLOOR PLAN		
A04-05	ROOF PLAN			M05-02	MECHANICAL ROOF PLAN	E04-05	FIRE ALARM ZONE MAP		
A04-06	LARGE SCALE FLOOR PLANS			M06-01	PLUMBING TYPICAL SUITES	E05-01	FIRE ALARM RISER DIAGRAMS		
A05-01	BUILDING ELEVATIONS			M06-02	HVAC TYPICAL SUITES	E06-01	ELECTRICAL TYPICAL SUITES		
A06-01	BUILDING SECTIONS			M07-01	MECHANICAL RISERS	E06-02	ELECTRICAL DETAILS (1 OF 2)		
A06-02	BUILDING SECTIONS			M07-02	MECHANICAL DETAILS	E07-01	ELECTRICAL DETAILS (2 OF 2)		
A06-03	BUILDING SECTIONS			M07-03	MECHANICAL DETAILS	E07-02	ELECTRICAL SCHEDULES (1 OF 2)		
A06-04	BUILDING SECTIONS			M08-01	MECHANICAL SCHEDULES		ELECTRICAL SCHEDULES (2 OF 2)		
A07-01	DETAILS								
A07-02	DETAILS								
A07-03	DETAILS								
A07-04	DETAILS								
A07-05	DETAILS								
A07-06	DETAILS								
A07-07	DETAILS								
A07-08	DETAILS								
A07-09	DETAILS								
A08-01	DOOR & WINDOW SCHEDULES, ELEVATIONS & DOOR DETAILS								
A08-02	TYPICAL WINDOW DETAILS								
A09-01	STAIR PLANS								
A09-02	STAIR SECTIONS								
A09-03	STAIR SECTIONS & DETAILS								
A10-01	MILLWORK PLANS								
A10-02	MILLWORK ELEVATIONS								
A10-03	MILLWORK ELEVATIONS								
A10-06	MILLWORK SPEC SECTION (MSD) DETAILS								
A10-07	MILLWORK SECTIONS & DETAILS								
A10-08	MILLWORK SECTIONS & DETAILS								
A11-01	REFLECTED CEILING PLAN - LEVEL 1								
A11-02	REFLECTED CEILING PLAN - LEVEL 2								
A11-03	REFLECTED CEILING PLAN - LEVEL 3								
A12-01	FINISH PLAN - LEVEL 1								
A12-02	FINISH PLAN - LEVEL 2								
A12-03	FINISH PLAN - LEVEL 3								
A12-05	LARGE SCALE FINISH PLANS								
A12-06	LARGE SCALE APARTMENT FINISH PLANS / ELEVATIONS								
A12-07	APARTMENT FINISH PLANS / ELEVATIONS / DETAILS - WAYFINDING								
A12-11	ROOM FINISH SCHEDULE APARTMENT								
A12-13	MATERIAL SPECIFICATIONS								

COLOURED PRINTS	
SHEET NO.	NAME/TITLE
A01-01	COVER PAGE
A02-04	SITE SURVEY
A03-03	EGRESS & RATINGS PLAN - LEVEL 1
A03-04	EGRESS & RATINGS PLAN - LEVEL 2
A03-05	EGRESS & RATINGS PLAN - LEVEL 3
A05-01	BUILDING ELEVATIONS
A12-01	FINISH PLAN - LEVEL 1
A12-02	FINISH PLAN - LEVEL 2
A12-03	FINISH PLAN - LEVEL 3
A12-05	LARGE SCALE FINISH PLANS
A12-06	LARGE SCALE APARTMENT FINISH PLANS / ELEVATIONS
A12-07	APARTMENT FINISH PLANS / ELEVATIONS / DETAILS - WAYFINDING

ISSUED FOR: BP APPLICATION

NOTE: THIS DRAWING TO BE PRINTED IN COLOUR

NOTES			
REVISIONS	#	DATE	DESCRIPTION
	3	04/16/24	GJP ISSUE FOR BP APPLICATION
	2	04/02/24	GJP FOR PRE-TENDER (90%) REVIEW
	1	03/05/24	GJP ISSUE FOR DP APPLICATION



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seals

drawn: **RMO**
scale:
file: **23002**

project:

PROJECT - BUILDING 'B'
MEDICINE HAT, ALBERTA

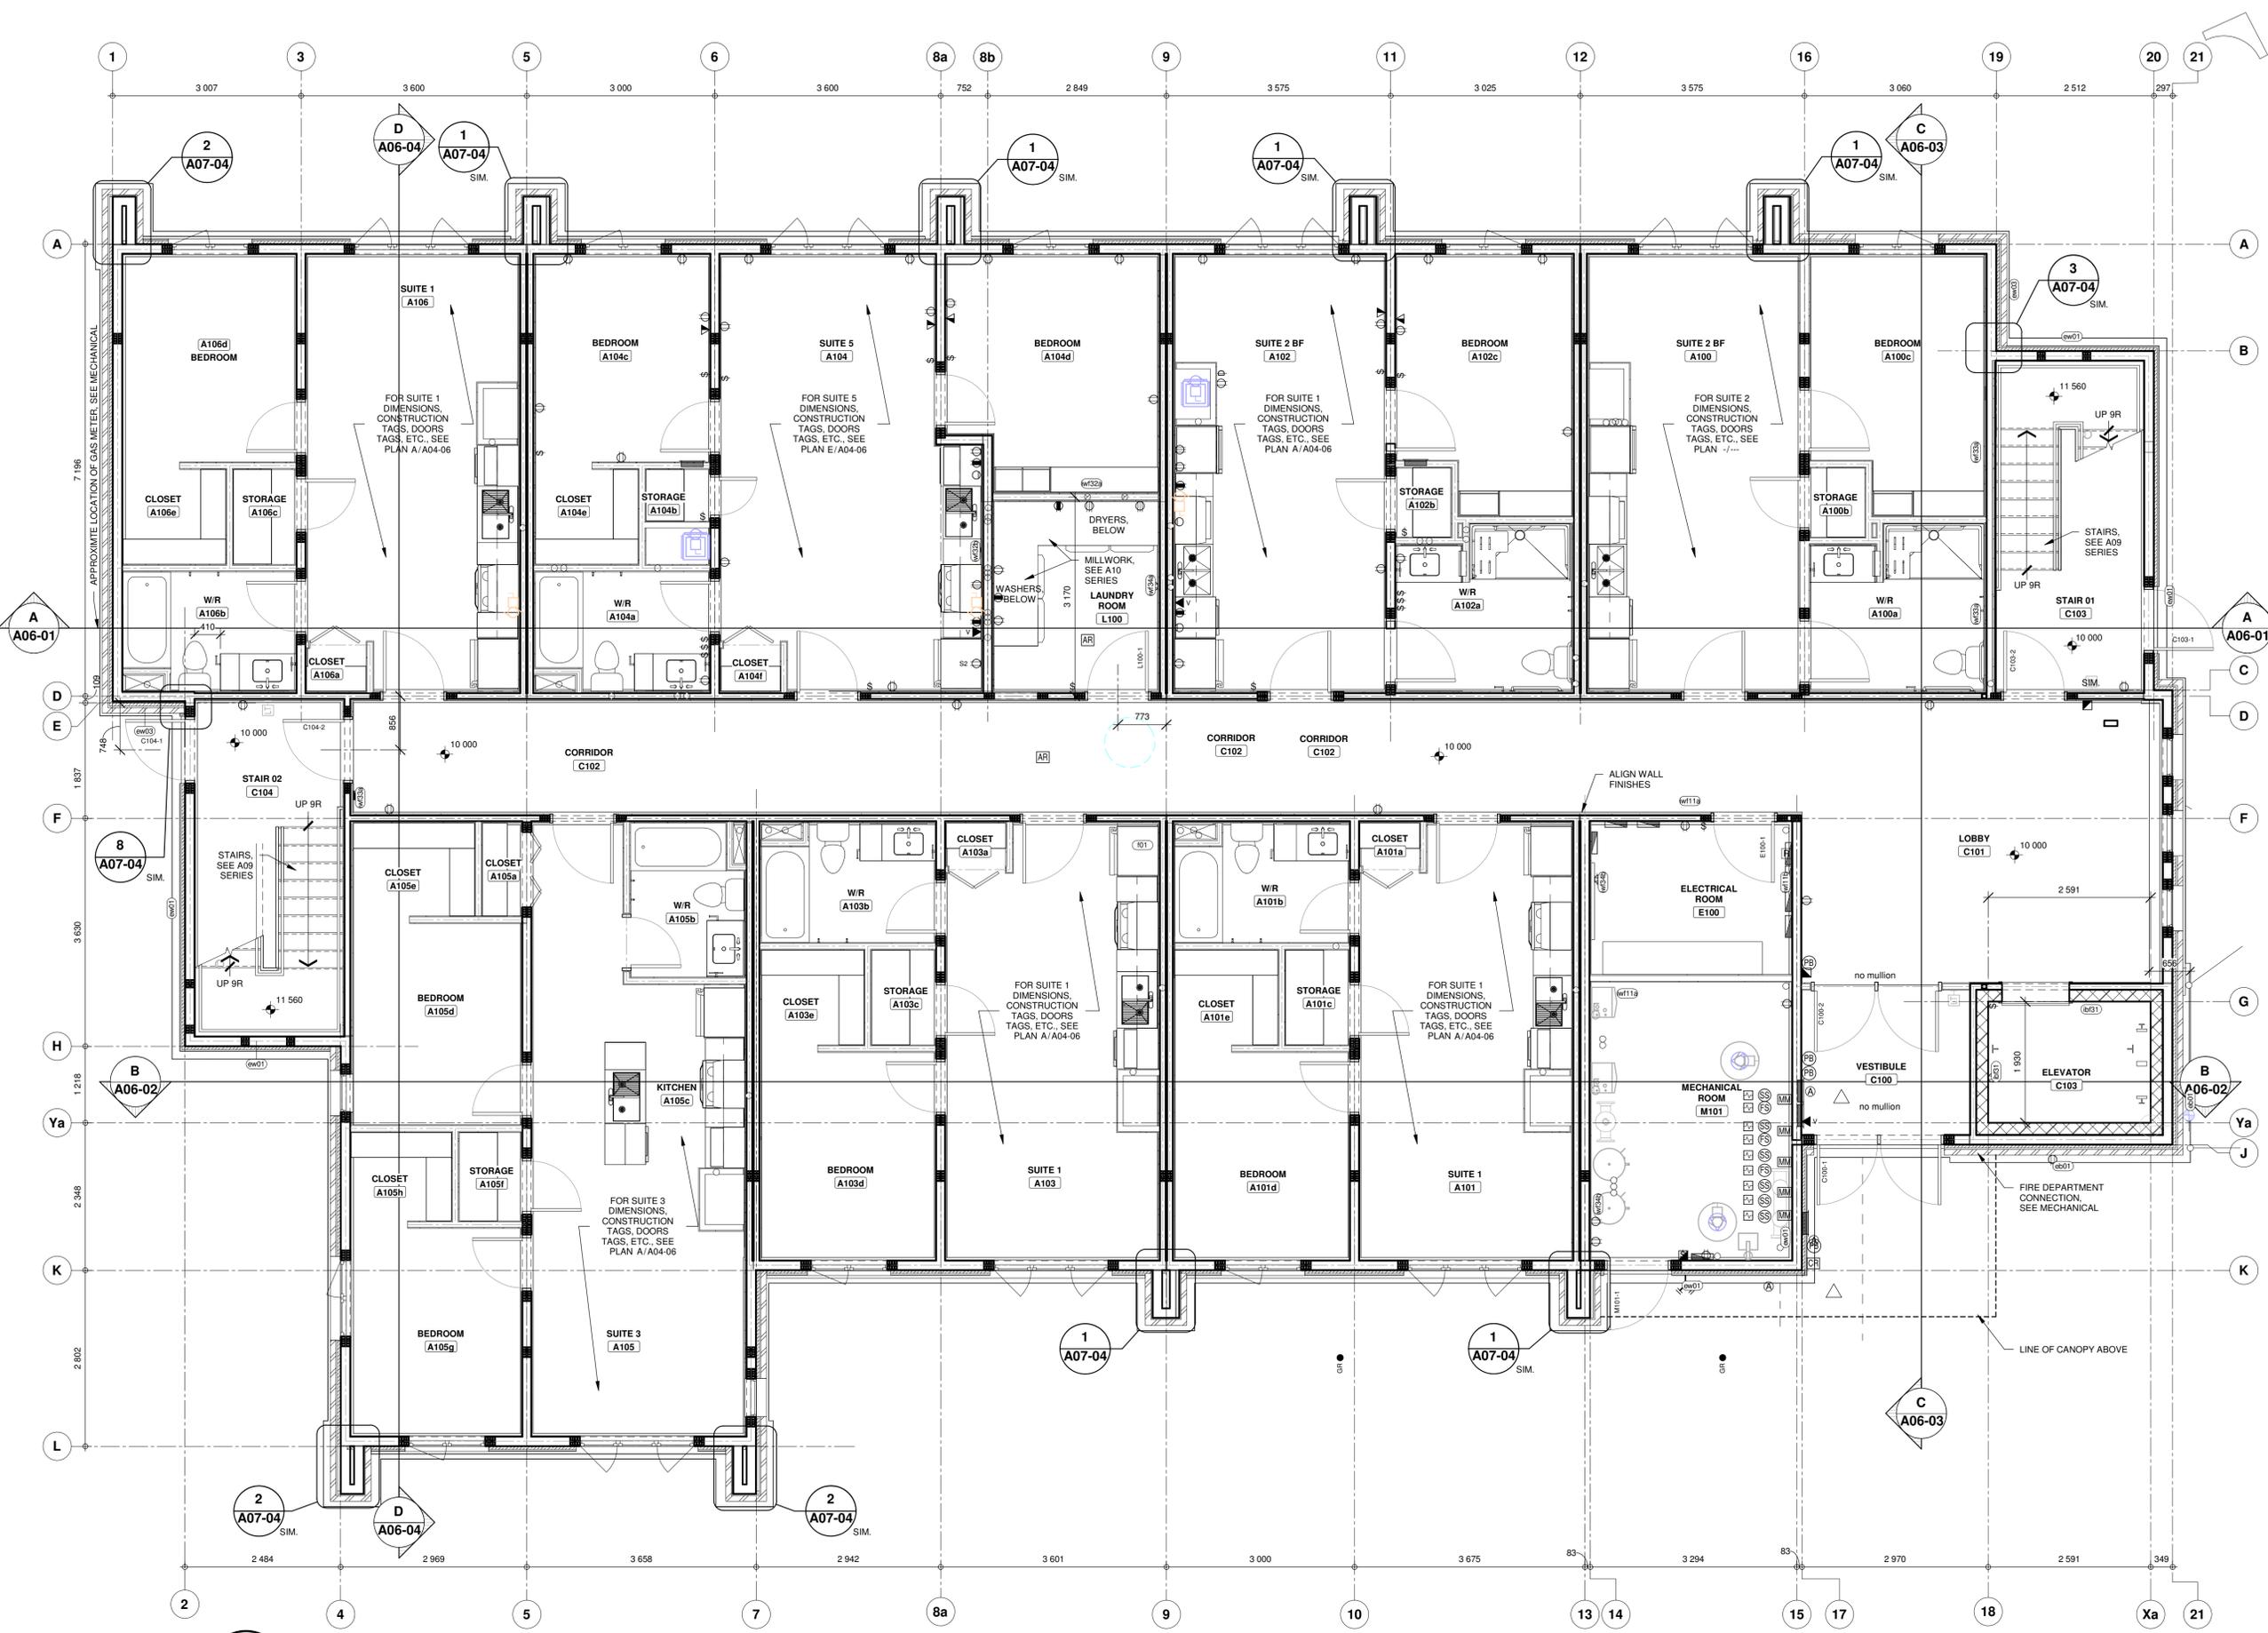
client:

drawing title:

COVER PAGE

drawing no: **A01-01**

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KEYPLAN

NOTES

- FOR EXTENSIVE PLANS FEATURING DIMENSIONS, WALL CONSTRUCTION TAGS, DOOR TAGS, & NOTES, SEE LARGE SCALE PLANS IN A04 SERIES.
- ALL WALL ANGLES ARE 45°, U.O.N.
- "VF" DENOTES VERTICAL FURRING. TYPICAL CONSTRUCTION: 16mm TYPE 'X' GWB ON 38x38mm WOOD STUD FRAMING @ MAXIMUM 600mm O.C. PLAN DIMENSIONS ARE TYPICALLY TAKEN FROM GRIDLINES TO CENTRELINE OF STUD FRAMING, OR TO FACE OF CONCRETE BLOCK OR CAST-IN-PLACE CONCRETE WALL.
- WHERE NOT DIMENSIONED, DOOR FRAMES ARE TO BE MINIMUM 75mm OFF ADJACENT CORNER.
- COORDINATE WITH A10 SERIES AND A12 SERIES TO ENSURE ALL APPLICABLE ITEMS HAVE ADEQUATE BACKING FOR MOUNTING.
- PIPING OCCURRING IN STC RATED WALL ARE TO BE DECOUPLED FROM THE STUDS USING AN OVERSIZE CLAMP. FOAM INSULATION IS TO BE ADDED AROUND THE PIPE.
- DOOR AND WINDOW FRAMES SHOWN IN PLAN AND SECTIONS ARE DIAGRAMMATIC ONLY. SEE A08 SERIES AND SPECIFICATIONS FOR FRAME PROFILES.

▲ - ACTIVE DOOR LEAF
 (A) - DOOR ACTUATOR BUTTON LOCATION

REVISIONS

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FWBA ARCHITECTS
 LETHBRIDGE · CALGARY · MEDICINE HAT

consultants: _____

seals: _____

drawn: _____ RMO
 scale: As indicated
 file: 23002
 project: _____

PROJECT - BUILDING 'B'
 MEDICINE HAT, ALBERTA

client: _____

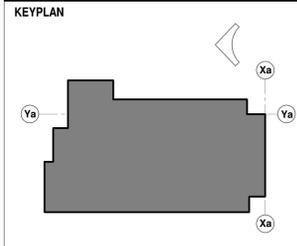
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FLOOR PLAN - LEVEL 1

drawing no: **A04-01**

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A PLAN
 - LEVEL 1
 1 : 50



- NOTES**
- TOP OF PARAPET DENOTES TOP OF VENEER AT PARAPETS, U.O.N.
 - STRUCTURAL, MECHANICAL, ELECTRICAL, AND CIVIL CONSTRUCTION SHOWN ON THESE DRAWINGS ARE DIAGRAMMATIC ONLY. REFER TO THE APPROPRIATE DISCIPLINE FOR THE EXACT SYSTEMS AND CONSTRUCTION. IT IS THE RESPONSIBILITY OF THE CONTRACTOR TO COORDINATE THE PROVISION OF ALL DISCIPLINE'S SYSTEMS AND CONSTRUCTION.
 - FOR DOOR TYPES, REFER TO DOOR SCHEDULE ON A08 SERIES.
 - FOR EXTERIOR WINDOW DIMENSIONS, SEE A08 SERIES.

LEGEND:
 CJ CONTROL JOINT
 TWS THROUGH WALL SCUPPER, SEE ROOF PLAN FOR LOCATIONS, SEE DETAIL /A07-.

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seals

drawn: KPS
 scale: 1 : 100
 file: 23002

PROJECT - BUILDING 'B'
 MEDICINE HAT, ALBERTA

client:

drawing title:

BUILDING ELEVATIONS

drawing no:

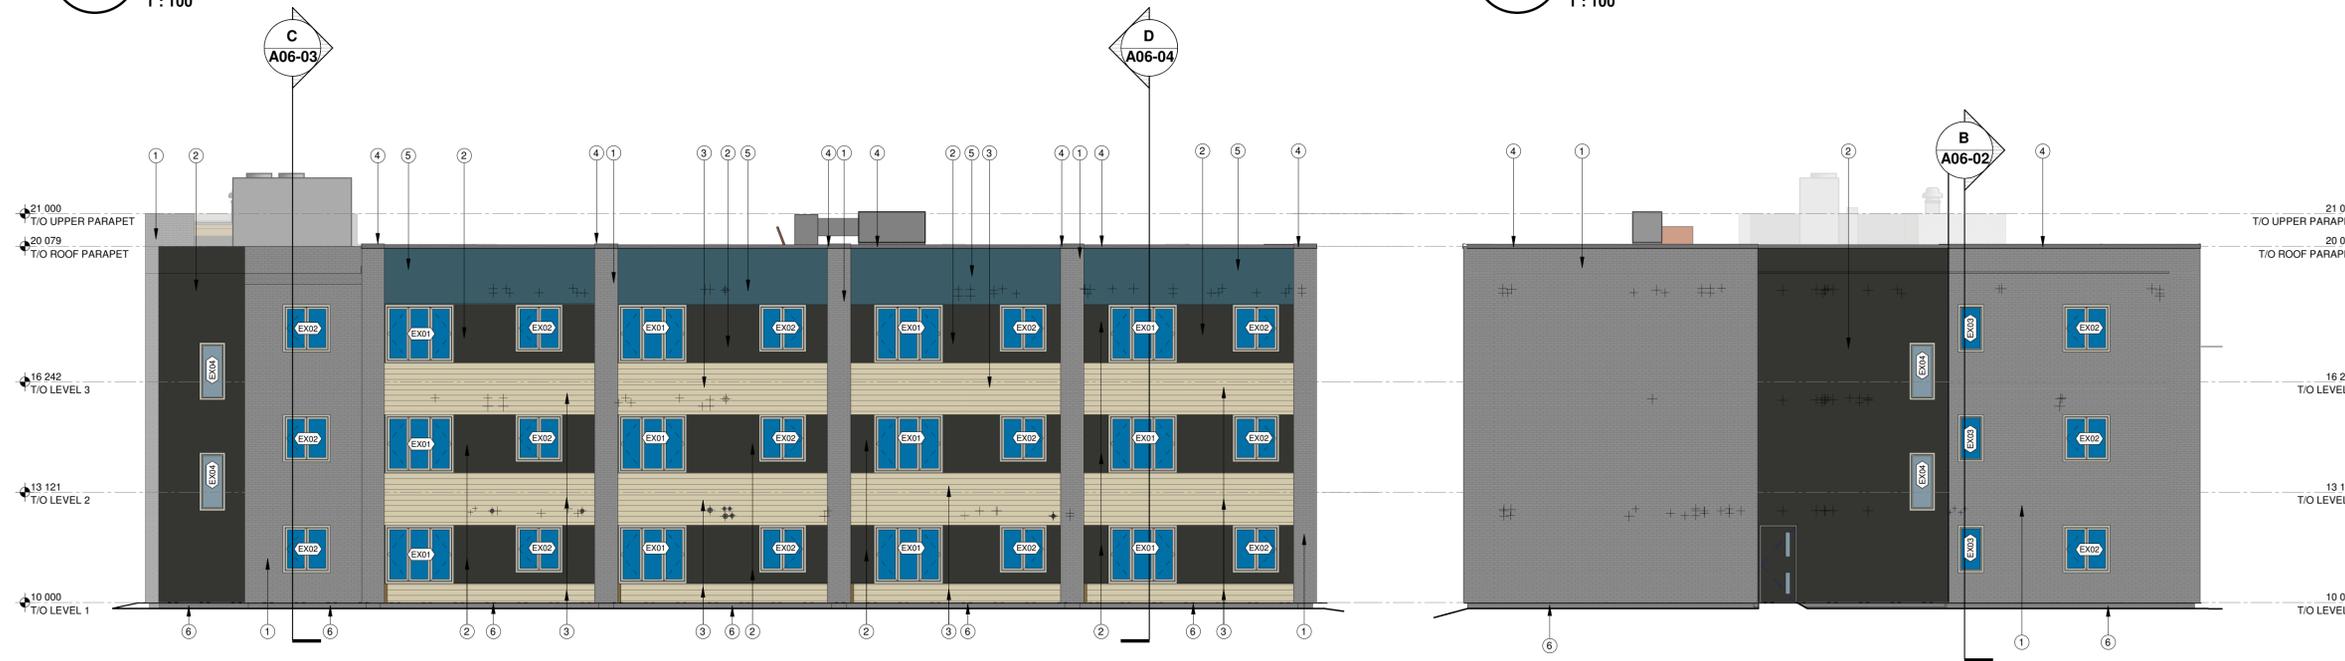
A05-01

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A BUILDING ELEVATION
 EAST ELEVATION
 1 : 100

B BUILDING ELEVATION
 SOUTH ELEVATION
 1 : 100



C BUILDING ELEVATION
 WEST ELEVATION
 1 : 100

D BUILDING ELEVATION
 NORTH ELEVATION
 1 : 100

EXTERIOR MATERIAL LEGEND

1	BRICK VENEER, RUNNING BOND - IXL GLEN GARY - COLOUR: STONINGTON GREY VELOUR
2	CEMENTITIOUS PANEL - HARDIEPANEL - COLOUR: RUBBER MEETS THE ROAD
3	CEMENTITIOUS LAP SIDING - HARDIEPANEL LAP SIDING - SMOOTH FINISH - COLOUR: KHAKI BROWN
4	PREFINISHED METAL FLASHING - COLOUR: TBD
5	CEMENTITIOUS PANEL - HARDIEPANEL - COLOUR: BLUE RIDGE
6	CONCRETE-FACED INSULATION

NOTE: THIS DRAWING TO BE PRINTED IN COLOUR